

ROCKY POINT GOLF COURSE

New Clubhouse


Tampa Sports Authority
 Tampa, Florida

Date: SEPTEMBER 15, 1994

Project No./File No.: 496 0005 0002 / RPSA1



Project Team:
 Jim Mehrtrator
 John Weber

Drawn By: J.W.
 Check By: JRM

Consultant:
 **PAULUS SOKOLOWSKI and SARTER, INC.**
 CONSULTING ENGINEERS
 245 BAYSHORE DRIVE, SUITE 200
 TAMPA, FLORIDA 33606
 (813) 311-0374

Revisions

Sheet No. **S2.0**

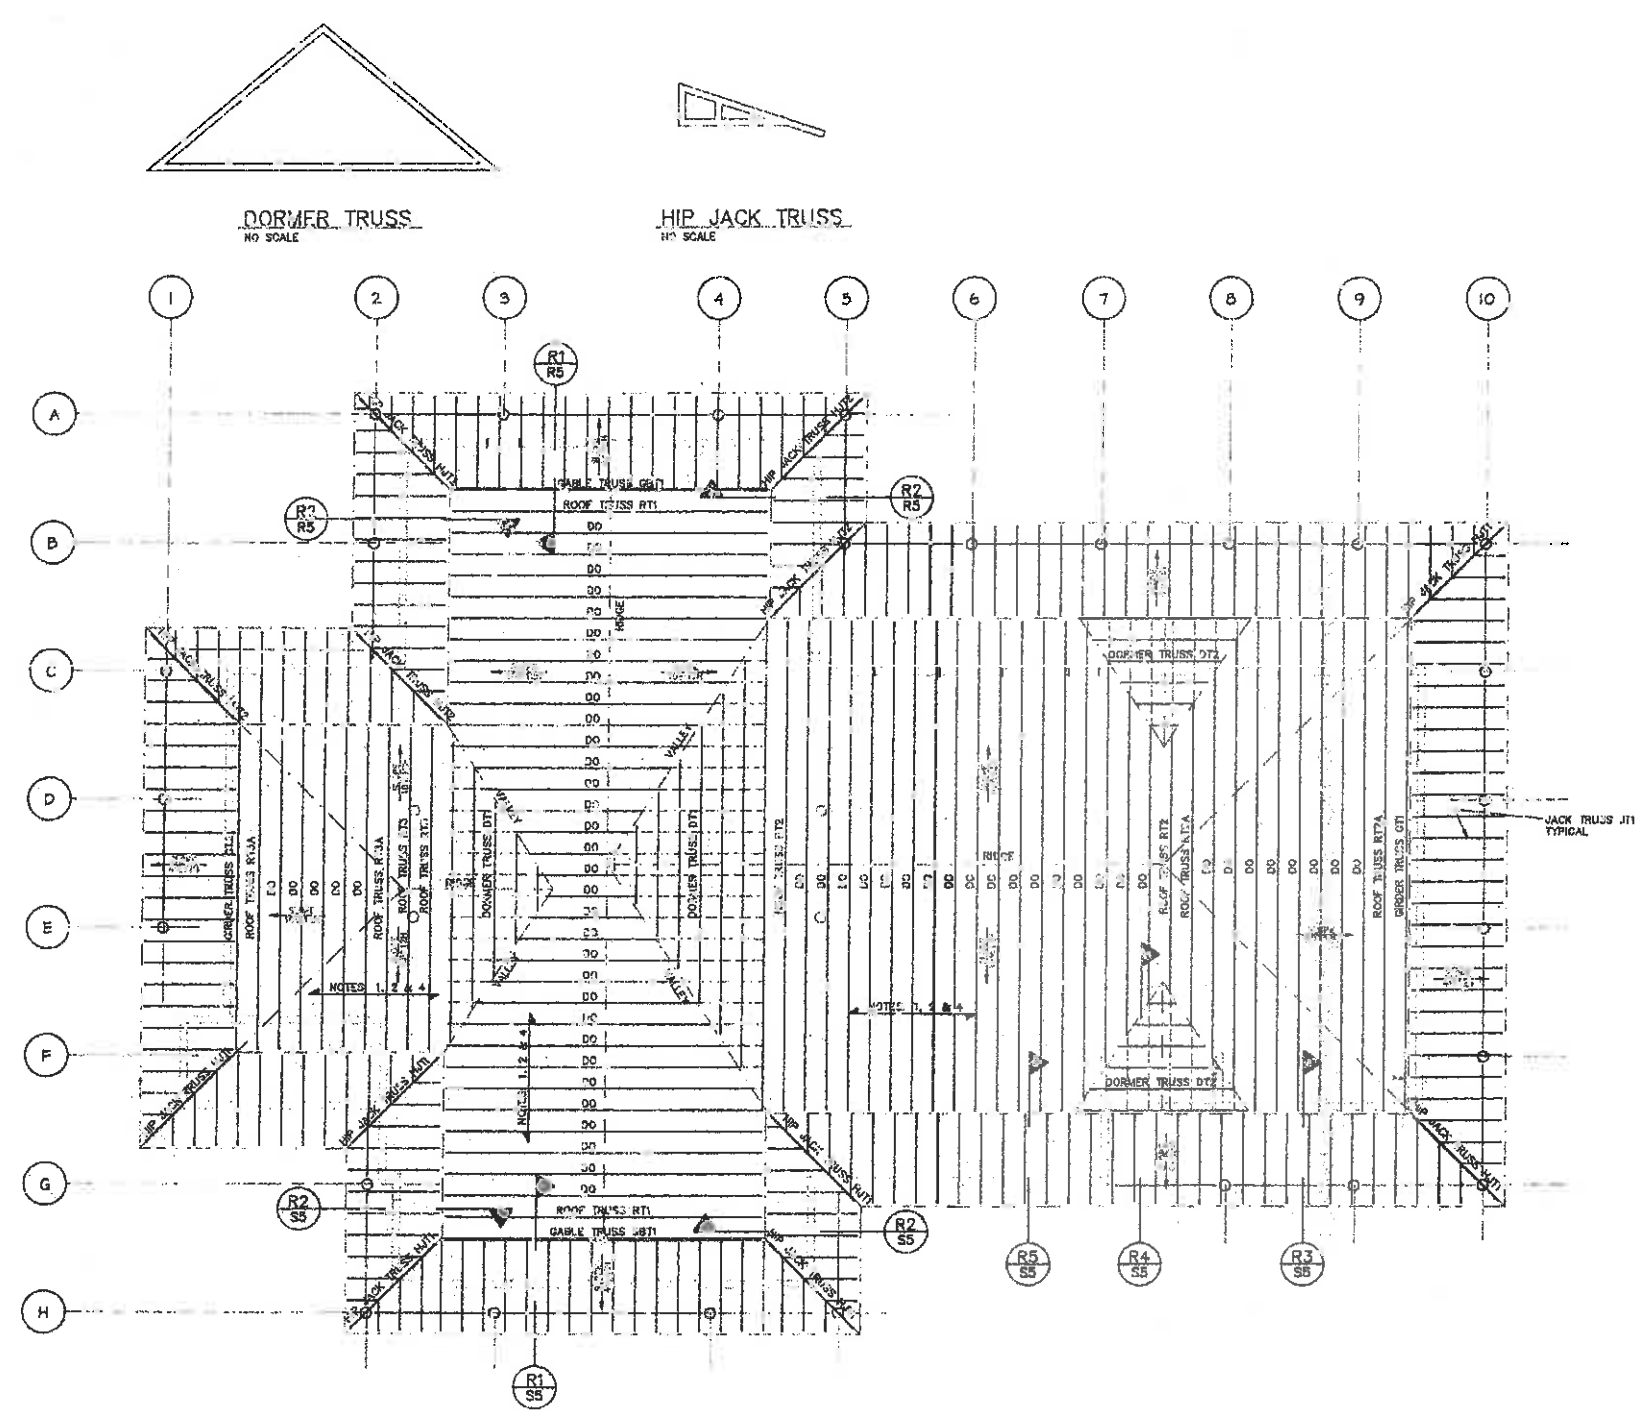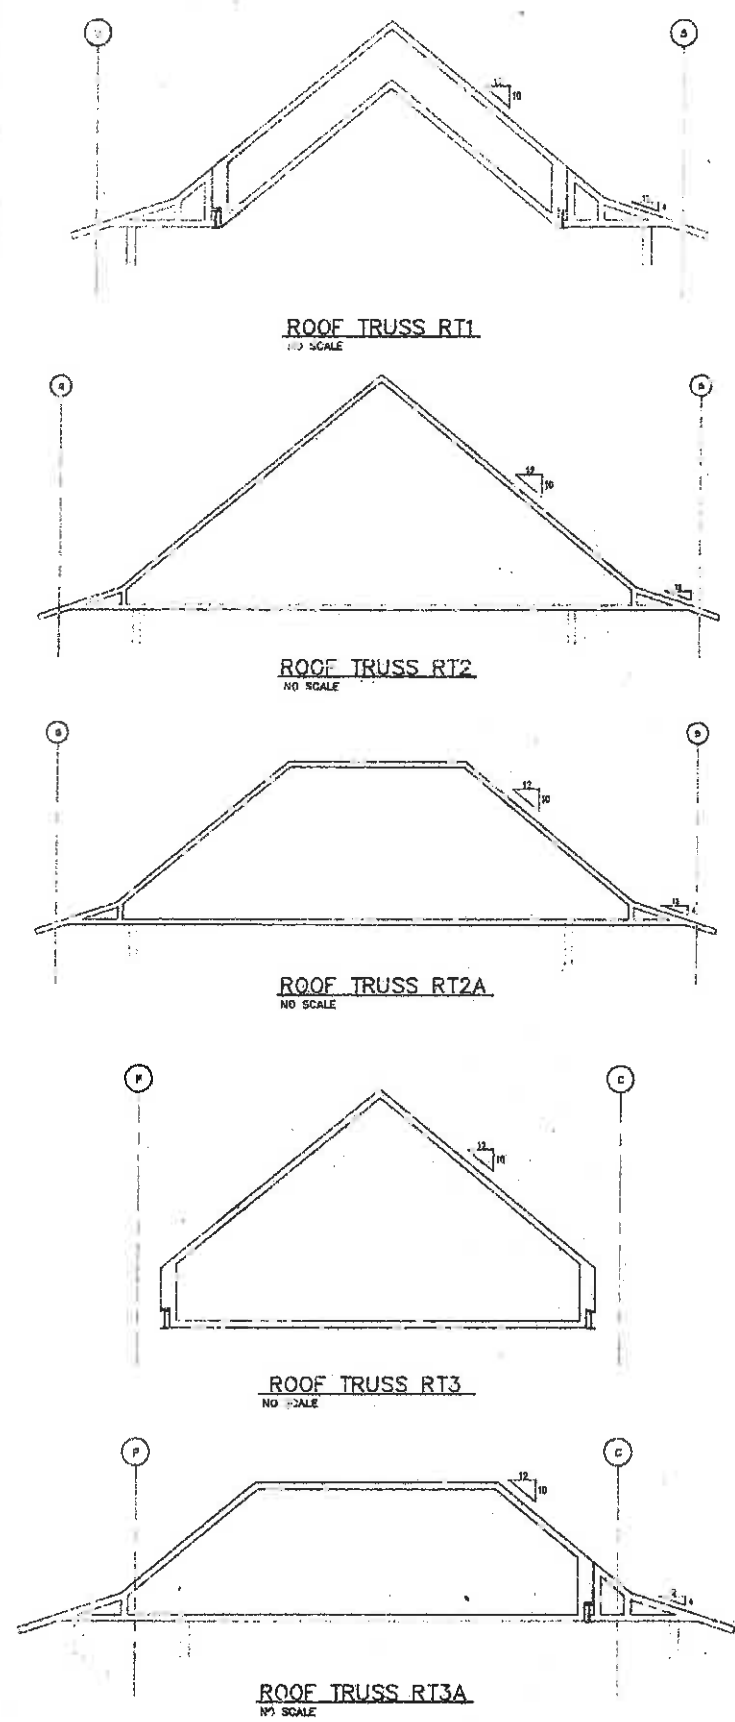

- ROOF FRAMING NOTES:**
- ROOF FRAMING SHALL BE 3/4" CDX PLYWOOD SHEATHING SPACING OVER PRE-FABRICATED WOOD TRUSSES OR JOISTS AS SHOWN ON PLAN.
 - UNLESS OTHERWISE NOTED, FASTEN ALL STRUCTURAL WOOD ELEMENTS IN ACCORDANCE WITH THE STANDARD BUILDING CODE LATEST EDITION, TABLE 1704.1 - FASTENING SCHEDULE EXCEPT DRYWOOD SHEATHINGS WHICH SHALL BE FASTENED IN ACCORDANCE WITH TABLE 1704.1 FOR HORIZONTAL PLYWOOD BLOCKED DIAPHRAGMS. SHEAR FOR ROOF DIAPHRAGM IS 320 POUNDS PER FOOT.
 - TRUSS MANUFACTURER TO DESIGN TRUSSES INDICATED THIS (T-C) ON PLAN FOR SUPPORT OF AIR HANDLING UNIT LOADS. WOOD MEMBERS SHALL BE LOCATED TO CLEAR UNIT, COORDINATE WITH MECHANICAL DRAWINGS FOR EXACT SIZE AND LOCATION OF UNIT.
 - DIRECTION OF EACH SPAN SHOWN THIS (S) ON PLAN.
 - COLUMN DESIGNATION SHOWN THIS (C) ON PLAN, FOR SIZE SEE COLUMN SCHEDULE ON DRAWING S1.0.
- LOAD CONDITIONS:**
- | | |
|------------------|-----------------|
| METAL ROOF | = 4 PSF |
| L'WOOD SHEATHING | = 4 PSF |
| TRUSS | = 9 PSF |
| M/E/P | = 6 PSF |
| CEILING/MECH. | = 7 PSF |
| TOTAL | = 30 PSF |
| LIVE LOAD | = 20 PSF |

JAMES R. MEHRTRATOR, P.E.
 FL. LIC. No. 33360

New Clubhouse

Tampa Sports Authority
 Tampa, Florida

Date:
 SEPTEMBER 18, 1991

Project No./File Name:
 435 (005 000 / EPC8A3)


Project Team:
 Larry Wilder
 John Schwanbeck
 John Felling
 Michael Smith

Drawn By: MS

Check By: LW

Consultant

Revisions
 Revised 9-2-91

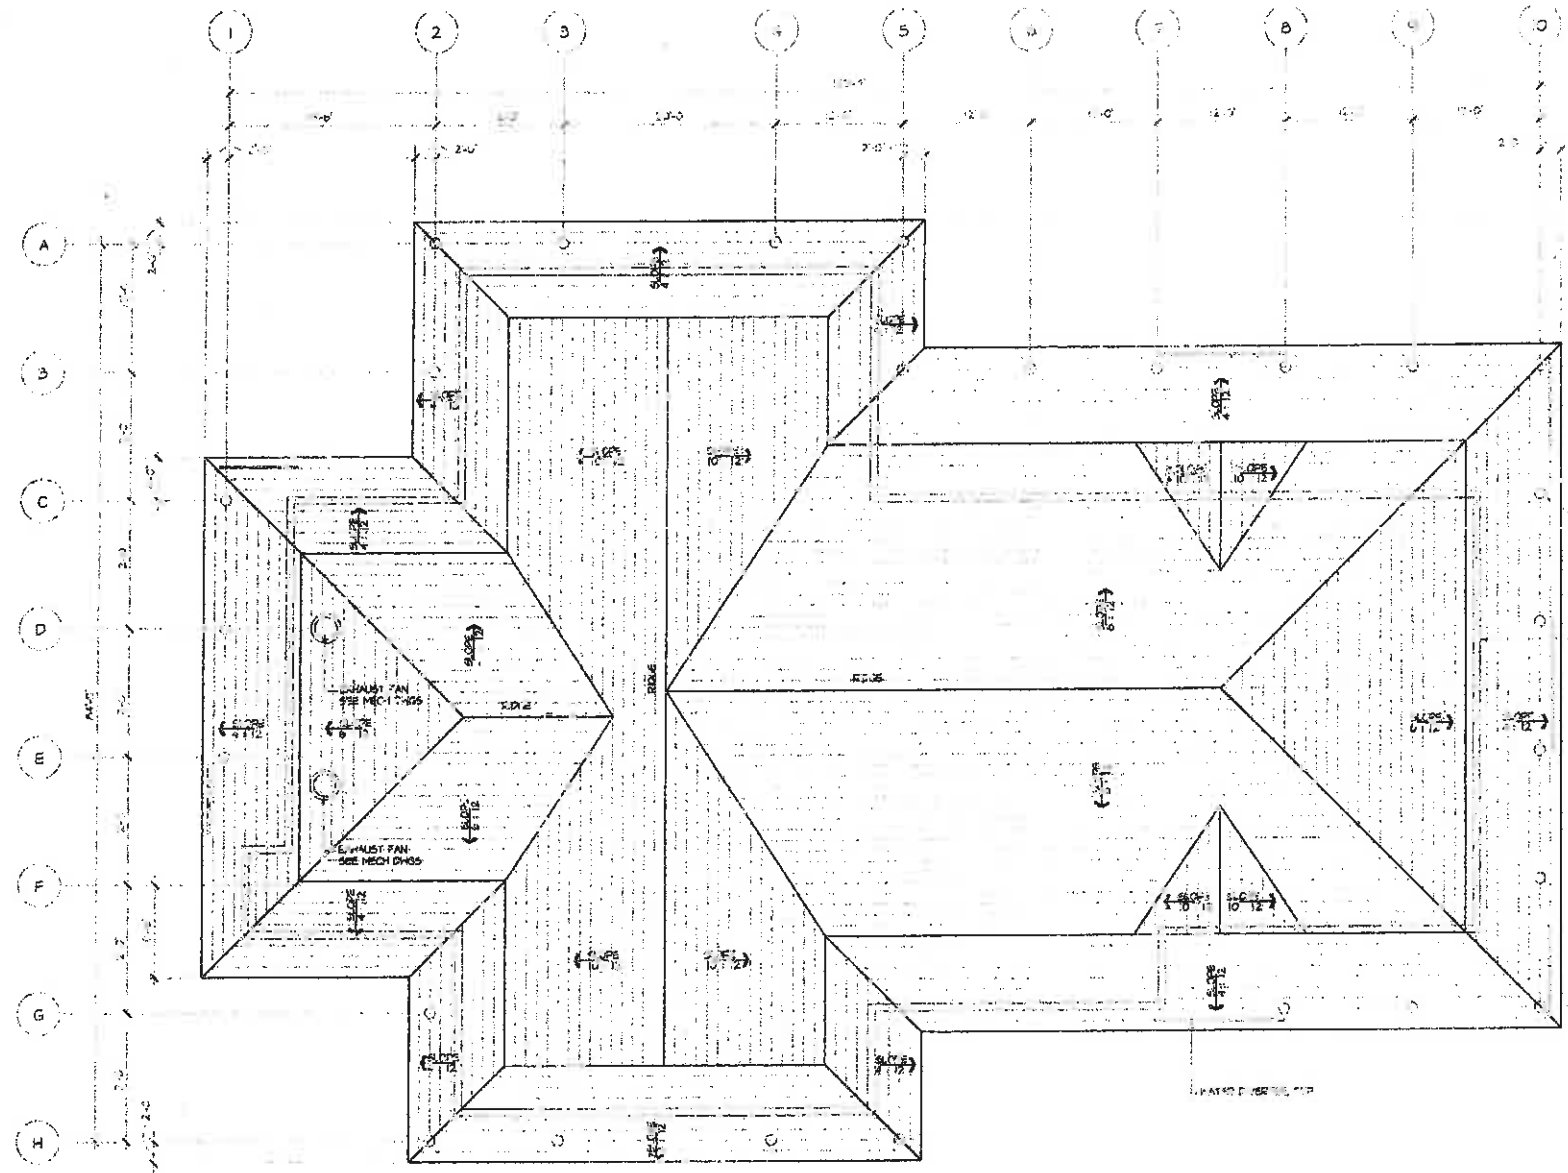


INDICATES COLUMN
 COLUMN BRICK TYP

INDICATES BRICK
 POINT-TO-POINT BRICK TYP

LIMIT OF BRICK TYP

ROOF PLAN GENERAL NOTES

- A. SEE PLAN
- B. INCLUDE ROOF DRAINAGE SYSTEMS PER LOCAL CODE PLUS BRICK WORK AND SIMILAR ELECTRICAL.

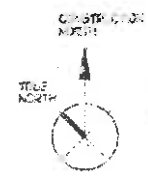

ROOF PLAN

SCALE 1/8" = 1'-0"



[Handwritten Signature]
 9/2/91

Sheet No.

A3.0